



**EROSION AND SEDIMENT CONTROL NOTES:**

- 1) PRIOR TO COMMENCEMENT OF LAND DISTURBING ACTIVITIES, THE CITY SHALL BE CONTACTED TO OBTAIN A CITY SITE INSPECTION.
- 2) CLEARING LIMITS WILL BE LIMITED TO A STRIP APPROXIMATELY 12 FEET IN WIDTH ALONG THE CENTER OF THE PATH. PRIOR TO CONSTRUCTION, THAT CENTERLINE WILL BE MARKED IN THE FIELD USING LATH OR PAINT. THIS STRIP WILL ALSO SERVE AS THE CONSTRUCTION ACCESS ROUTE FOR THE PROJECT. MOVEMENT OF VEHICLES BETWEEN PAVEMENT AND DISTURBED AREAS SHALL BE MINIMIZED.
- 3) ALL STORM DRAIN INLETS WHICH MAY RECEIVE RUNOFF FROM THE CONSTRUCTION AREA SHALL BE PROTECTED BY STORM DRAIN INLET PROTECTION BMPs.
- 4) DISTURBED AREAS WILL BE COVERED BY MULCH AS RAPIDLY AS POSSIBLE FOLLOWING DISTURBANCE. PERMANENT EROSION CONTROL WILL BE PROVIDED BY REVEGETATING THE DISTURBED AREA WITH TURF GRASS APPROVED BY THE SCHOOL DISTRICT.
- 5) SEDIMENT CONTROL WILL BE PROVIDED BY THE EXISTING GRASS COVER. THERE ARE NO STORM DRAINAGE INLETS WITHIN THE PROJECT AREA.
- 6) SEDIMENT TRACKED ONTO EXISTING PAVED AREAS SHALL BE REMOVED BY SWEEPING. WASHING OF EXISTING PAVED SURFACES INTO THE STORM SYSTEM WILL NOT BE ALLOWED.
- 7) TREE PROTECTION SHALL BE ADDED AT THE PERIMETER OF TREES ADJACENT TO THE PATH CONSTRUCTION AND AT THE PERIMETER OF THE OUTDOOR CLASSROOM CONSTRUCTION SPACE. SEE DETAIL, SHEET C1.1. THERE WILL BE NO IMPACT TO ADJACENT TREES, AND NO TREES WILL BE REMOVED IN THIS PROJECT.
- 8) SANITARY SEWER LOCATED BASED ON AS-BUILT DRAWINGS PROVIDED BY THE CITY OF VANCOUVER.

CLIENT:  
 HARNEY P.T.O.  
 C/O HARNEY ELEMENTARY SCHOOL  
 3212 E. EVERGREEN BLVD.  
 VANCOUVER, WA 98661

EXISTING CONDITIONS, GRADING, EROSION CONTROL, AND STORMWATER PLAN FOR:  
**HARNEY ELEMENTARY  
 OUTDOOR IMPROVEMENT PROJECTS**

**OLSON** LAND SURVEYORS  
 ENGINEERS  
 ENGINEERING INC. 222 E. EVERGREEN, VANCOUVER, WA 98660  
 206-286-8608

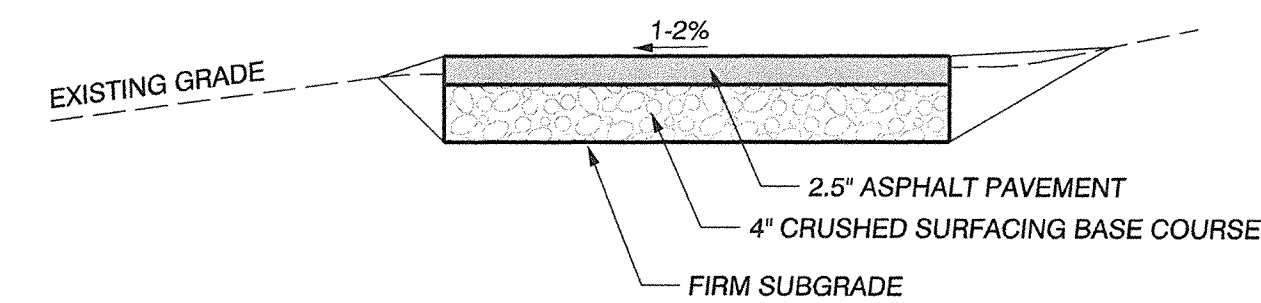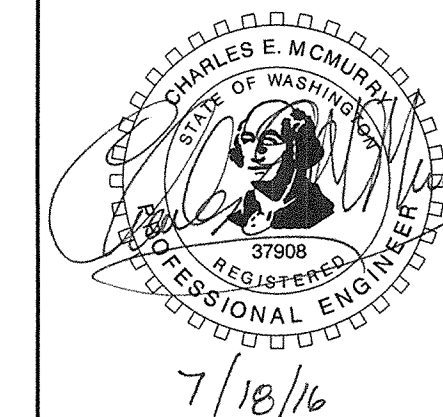

**PAVED PATH SECTION**  
 N.T.S.

**CHANGES / REVISIONS**

DESCRIPTION:	DATE:

DESIGNED: CEM  
 DRAWN: CEM  
 CHECKED: PAT  
 DATE: JANUARY 2016  
 SCALE: H: 1"=40'  
 V:  
 COPYRIGHT 2016, OLSON ENGINEERING, INC.  
 HARNEY ELEMENTARY  
 OUTDOOR IMPROVEMENT PROJECTS  
 JOB NO.: 9367.01.01

**SHEET**  
**C2.0**